### Basix-Commitments /for details: See the Basix certificate/ ALTERNATIVE WATER

Install a rainwater tank of at least 2000 litres (For Units 1,2,3 &4), collect rain runoff from at least (4 m²-Unit 1, 40 m²-Unit 2, 110 m²-Unit 3, 50 m²-Unit 4) of the roof, connect to all toilets and laundries, at least one outdoor tap /per unit/ in the development

# FIXTURES (for each unit)

Shower heads-3 star (> 6.0 but <= 7.5 L/min), Toilets-4 star, Kitchen Tap - 5 star, Basin Tap - 5 Star

Thermal Comfort-Simulation method /for details: see the Nathers certificate/
Hot Water System: gas instantaneous with a performance of 6 stars (For Each Unit)
Heating (For Each Unit) - Single-phase air-conditioning; Energy rating: EER 3.0-3.5 (zoned)
Cooling (For Each Unit) - Ceiling fans +Single phase air-conditioning; Energy rating: EER 3.0-3.5 (Zoned)

#### VENTILATION

(Each Unit ) - Bathrooms, Laundry & Kitchen (individual fan, ducted; Operation: manual

### NATURAL LIGHT

(Unit 1&2) - Window (Skylight) in 2 Bathrooms/Toilets

(Unit 3) - Window (Skylight) in the Kitchen and 2 Bathrooms/ Toilets

ARTIFICIAL LIGHT - fluorescent or (LED)/ DEDICATED/:

(Unit 1) 3 in the Bedrooms/study,3 in the living, the Kitchen, Bathrooms, Laundry and ALL Hallways, (Unit 2) 5 in the Bedrooms/study,2 in the living, the Kitchen, Bathrooms, Laundry and ALL Hallways, (Unit 3,4 &5) 4 in the Bedrooms/study,2 in the living, the Kitchen, Bathrooms, Laundry and ALL Hallways

OTHER - Install a gas cooktop & electric oven in the kitchen of each dwelling, a fixed outdoor clothes drying line for each dwelling, a fixed indoor or sheltered clothes drying line for each dwelling, refrigeration space as well ventilated for each dwelling

COMMON AREA VENTILATION - Carpark area ventilation - exhaust only, Operation-carbon monoxide monitoring + VSD fan


COMMON AREA LIGHTING - Carpark-Fluorescent or compact fluorescent lighting, Operation - time clock and motion sensors

LIFT (no.1) - geared traction with VVAC motor

# Note:

- All coffer ceiling verticals and walls against the roof-space, to be insulated, with the same insulation as the ceiling insulation,
- All downlights: IC-F/ IC-4 (insulation covered/ including the control gears) rated as per AS/NZS standard 60598 and IP(sealed) rated as per BS EN 60529:1992, European IEC 60509:1989
- (where the roof is extended over an open area such as a deck or carport): A barrier
  to be installed within the roof space to separate the space above the zoned part of
  the house and the space above the open veranda.

Site Area = 1115m², Zone = R3, Landlocked site									
DESCRIPTION	DCP REQUIREMENT	PROVIDED							
Minimum Lot Size		1115m²							
Height	11m and 8m	8.5m and 7m							
FSR	0.6 = 669m <sup>2</sup>	667m²							
Frontage	24m	22.2m - Landlocked							
Front Setback	5 to 7m	6m							
Side Setback	3m and 4.5m	3m and 4.5m							
Rear Setback	15% Ave	15% Ave							
Deep Soil Zone	30% = 335m <sup>2</sup>	345m²							
Landscaped Area	40% = 446m <sup>2</sup>	455m²							

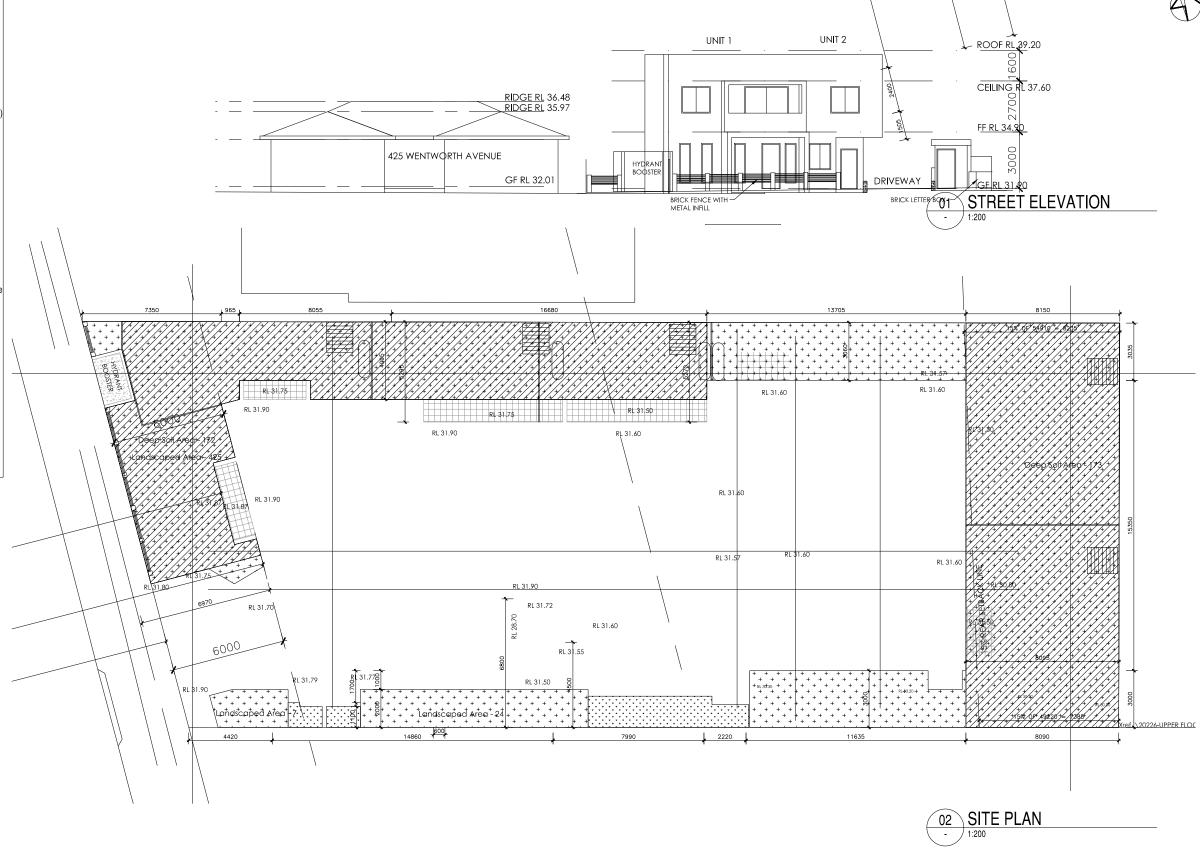

ALL WORKS TO FULLY COMPLY WITH BCA AND RELEVANT AUSTRALIAN STANDARDS	DATE 28.10.19 05.02.20	REV DA1 DA2	COMMENT ISSUED FOR DA DRAWINGS REVISED IN DISCUSSION WITH COUNCIL	CONSULTANTS:  TCS ARCHITECTS	66 Oatlands Street Wentworthville NSW 2145 Tel: 02 9863 8096 / 0403 005 376	THANABALASINGHAM		PROPOSED DEVELOPMENT AT 427 WENTWORTH AV, TOONGABBIE		
ALL DIMENSIONS TO BE VERIFIED ON SITE PRIOR TO COMMENCEMENT OF ON-SITE AND OR OFF-SITE FABRICATION. FIGURED DIMENSION TO BE TAKEN IN PREFERENCE TO SCALED DIMENSIONS. THIS DRAWING IS COPYRIGHT AND REMAINS THE PROPERTY OF TCS ARCHITECTS. REPRODUCTION IN WHOLE OR PART OF THESE DRAWINGS WITHOUT WRITTEN CONSENT CONSTITUTES AN INFRINGEMENT OF COPYRIGHT.	01.07.02	DA3	DRAWINGS REVISED IN DISCUSSION WITH COUNCIL DRAWINGS REVISED IN DISCUSSION WITH COUNCIL			PROJECT NO.: 20 DRAWN:		TITLE: SITE PLAN STREET ELEVATIO	<u> </u>	OF COURT
						STAGE / STATUS:		SCALE: AS SHOWN @ A3	DRAWING NO.:	REV: